House Plan Zone, LLC.

Designing Homes HOUSE PLAN ZONE Building Relationships

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STANDARD ABBREVIATIONS

<u>@</u> #	AT	JT.	JOINT
‡	POUND(S)	JST.	JOIST
		JSTS.	JOISTS
APPROX.	APPROXIMATELY	ī 	116117
PAGE	PAGEMENT		LIGHT
BASE. B/T	BASEMENT	LIN.	LINEN
BLK.	BETWEEN BLOCK	MANUE	MANUFACTURER
	BLOCKING	MAS.	MASONRY
BD.	BOARD	MAX.	MAXIMUM
BRD.	BOARD	MTL.	METAL
	BOTTOM	MIN.	MINIMUM
BLDG.	BUILDING		
		<u>N.I.C.</u>	NOT IN CONTRACT
CAB.	CABINET		
CLG.	CEILING	<u>0.C.</u>	ON CENTER
CLR.	CLEAR	OIC	ON CENTER
CLOS.	CLOSET COLUMN	<u>OPT.</u> O.S.B.	OPTIONAL ORIENTED STRAND BOAR
<u>COL.</u> COLS.	COLUMNS	<u>0.5.Б.</u> ОТS	OWNER TO SELECT
	CONCRETE	0.T.S	OWNER TO SELECT
CMU	CONCRETE MASONRY UNIT	<u>0.1.5</u>	OF WEIN TO SEELOT
C.U.	CONDENSOR UNIT	PG.	PAGE
	CONNECTION	PAN.	PANTRY
CONT.	CONTINUOUS	PL.	PLATE
COVER'G	COVERING	<u>P</u>	PLATE
C S	CRAML SPACE	PLY'MD	PLYMOOD
		PLYW'D	PLYMOOD
	DECORATIVE	POLY.	POLYETHYLENE
DET	DETAIL		POUNDS PER SQUARE IN
DIA.	DIAMETER	PRE-FAB	PREFABRICATED
DM DBL.	DISHMASHER DOUBLE	RE:	REFERENCE
DBL. DF	DOUGLAS FIR	REF	REFRIGERATOR
D D	DRYER		REINFORCED
	DISTER		RESISTANCE
EA.	EACH		RETURN AIR
	ELEVATION		RETURN AIR GRILLE
ENG.	ENGINEER	REQ'D	REQUIRED
FT.	FEET		SCREEN
F.F.L.	FINISHED FLOOR LINE	SHLVS.	SHELVES
FIN.	FINISH	SHR.	SHOWER
F.C.	FIRE CODE	SHMR.	SHOWER STRONG TIE
FLR.	FLOOR	SST. SP	SIMPSON STRONG TIE
FTG. FOUND.	FOOTING FOUNDATION	SPECS.	SOUTHERN PINE SPECIFICATIONS
FND.	FOUNDATION	<u>51 LOS.</u> 5Q.	SQUARE
FR.	FREEZER	5.F.	SQUARE FOOTAGE
1 13.	I NEELL N	STL.	STEEL
GA.	GAUGE	<u> </u>	
GALV.	GALVANIZED	THK.	THICK
GYP.	GYPSUM	THK.	THICKNESS
		TBD.	TO BE DETERMINED
HDR.	HEADER	TR.	TRANSOM
HVAC	HEATING, VENTILATION &	TYP.	TYPICAL
	AIR CONDITIONING		I Wasa Tile 2 A. William
HT.	HEIGHT		UNDER THE COUNTER
HTS.	HEIGHTS	UTIL.	UTILITY
HORIZ.	HORIZONTAL	\/A \ I	\/A NITY
IN.	INCHES	VAN. VERT.	VANITY VERTICAL
	INCLUDE	<u>Y L N I .</u>	YLNIIOAL
INSUL.	INSULATION	MH	MATER HEATER
ונוכיאוו			



BB-3366

SHEET INDEX:

- 1 COYER SHEET
- 2A FOUNDATION PLAN
- 2B FOUNDATION DETAILS
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- 4 EXTERIOR VIEWS
- 5 EXTERIOR VIEWS
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- 7 ROOF PLAN
- 8 ELECTRICAL PLAN

CODE DISCLAIMER

1. THESE PLANS WERE DESIGNED TO MEET IRC 2018 AT THE TIME OF THEIR CREATION AND MORE SPECIFICALLY THE MINIMAL LOCAL CODES OF THE SOUTH MISSISSIPPI AREA. IT IS HIGHLY RECOMMENDED THAT THESE PLANS BE REVIEWED BY A LOCAL STRUCTURAL ENGINEER PRIOR TO CONSTRUCTION.

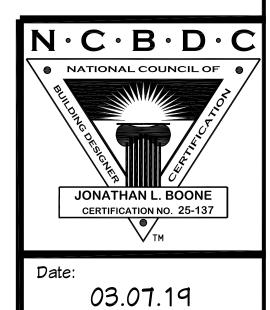
CONSTRUCTION MANUAL

NIN. MINDOM
N.M. MIRE MESH
N/ MITH
ND. MOOD
NFCM MOOD FRAME

2. BEAMS AND FLOOR JOISTS ARE NOT SIZED DUE TO THE MANY GEOGRAPHIC LOCATIONS THESE PLANS ARE SOLD. THESE ITEMS SHALL BE SIZED BY A LOCAL ENGINEER OR MANUFACTURER.

3. ALL CEILING & FLOOR JOISTS (IF CONVENTIONAL FRAMING) SHOULD BE SIZED USING THE LATEST VERSION OF THE IRC OR APPLICABLE CODES AT SITE TO MEET THE LOCAL REQUIREMENTS SUCH AS SNOW LOADS AND OTHER FACTORS. THE CEILING JOISTS SIZES LABELED (IF PRESENT) WERE SIZED USING THE 2018 IRC AT THE TIME OF THEIR CREATION. THEY MUST BE VERIFIED AND MODIFIED AS REQUIRED TO MEET THE LATEST EDITION OF THE (IRC) INTERNATIONAL RESIDENTIAL CODE.

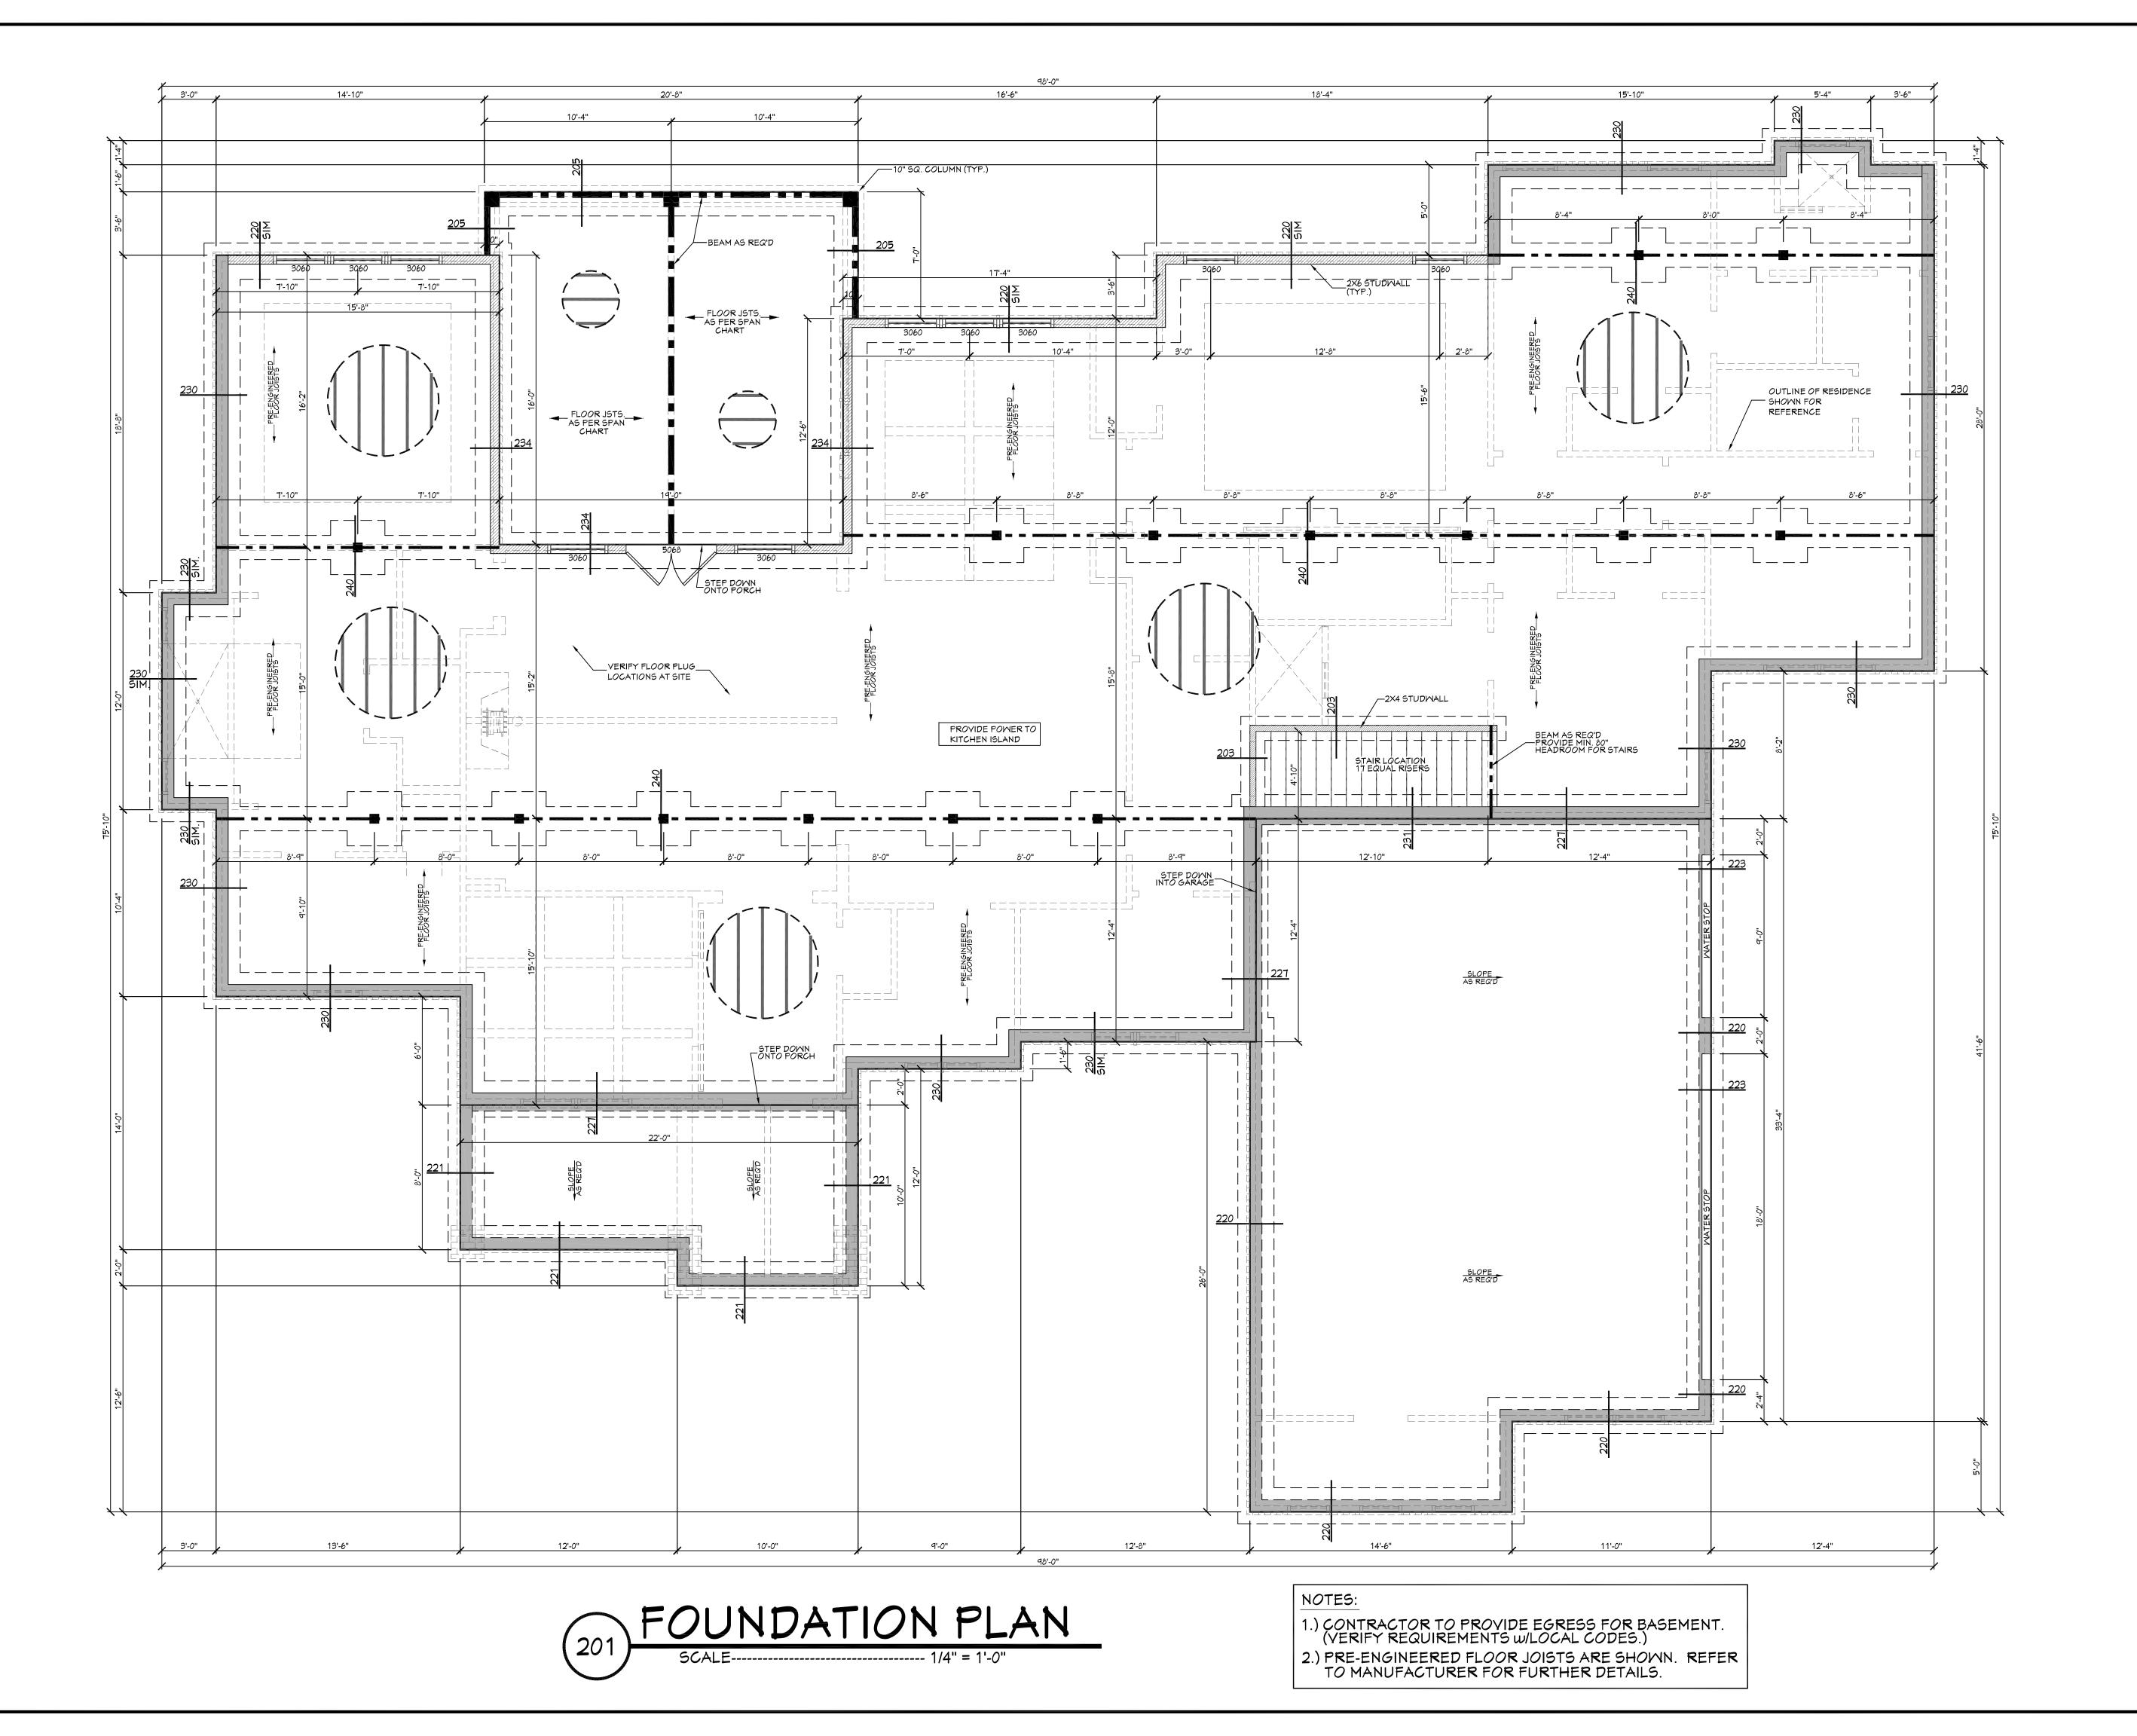
4. ALL FOUNDATIONS AND FOOTING DETAILS SHALL BE REVIEWED AND APPROVED BY A LOCAL ENGINEER.
5. CONTRACTOR SHALL PROVIDE ALL HIGH WIND STRAPPING AND ANCHOR BOLTS AS REQUIRED BY THE LOCAL CODE REQUIREMENTS AND THE LATEST VERSION OF THE IRC.



03.07.19

Drawn By:

J.A.L.



Designing Homes

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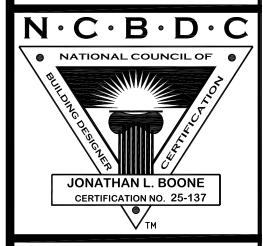
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Drawn Plan ID:

B-3366

And effort in the development of these plans and the completion of the building codes and site specific conditions. House Plan Zone, LLC.

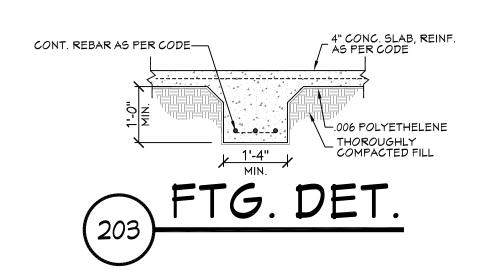
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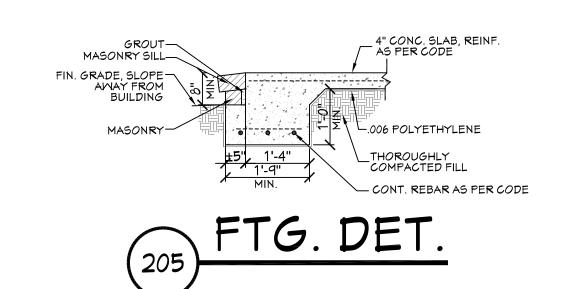
Drawn By: J.A.L.

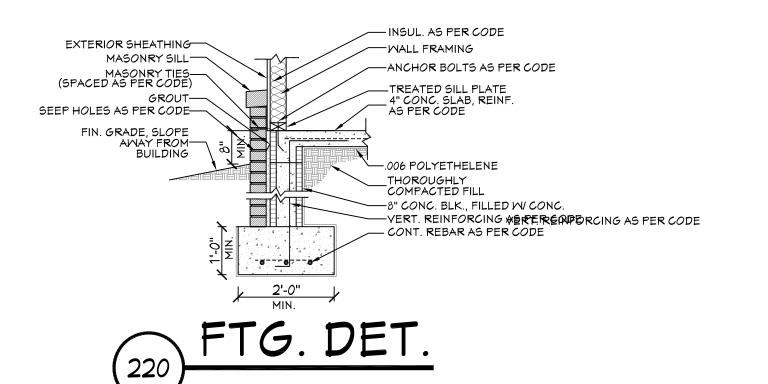
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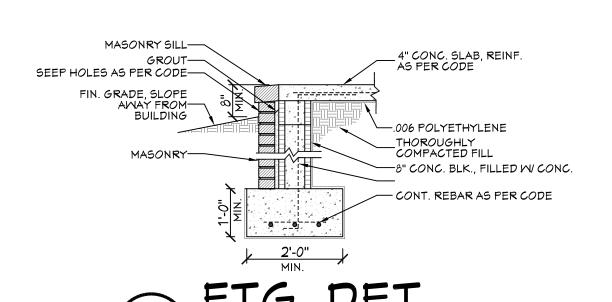
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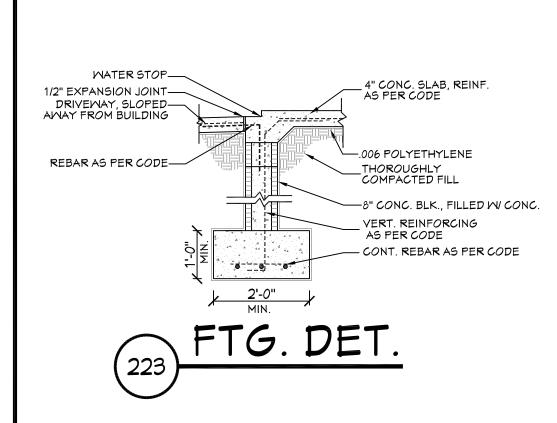
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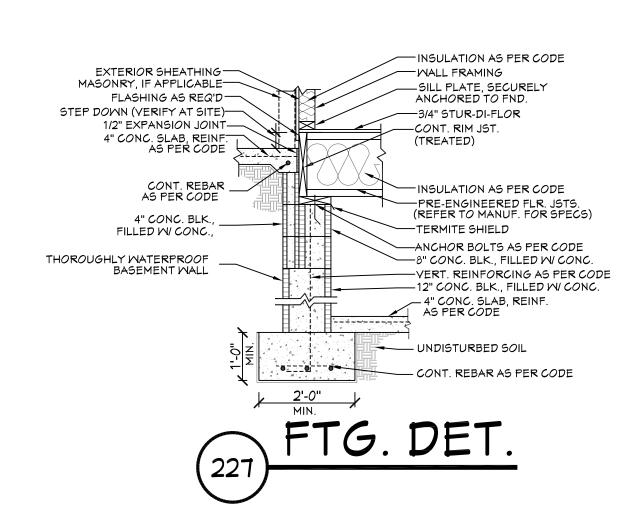


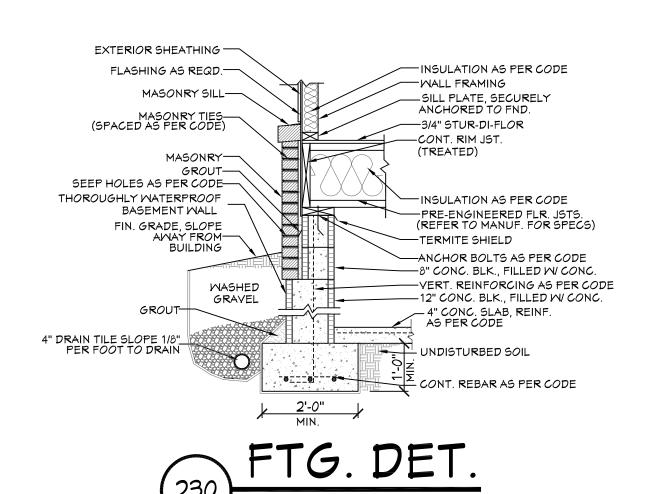


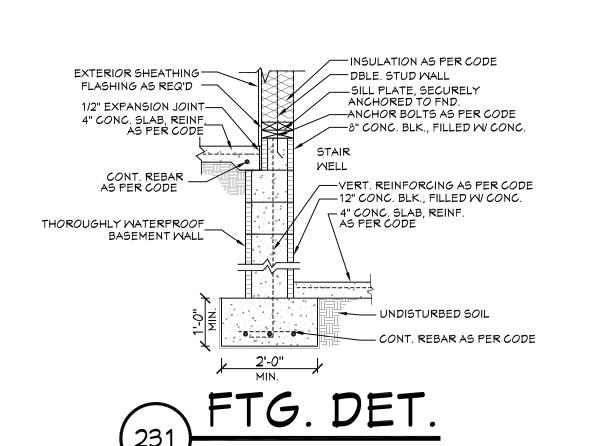


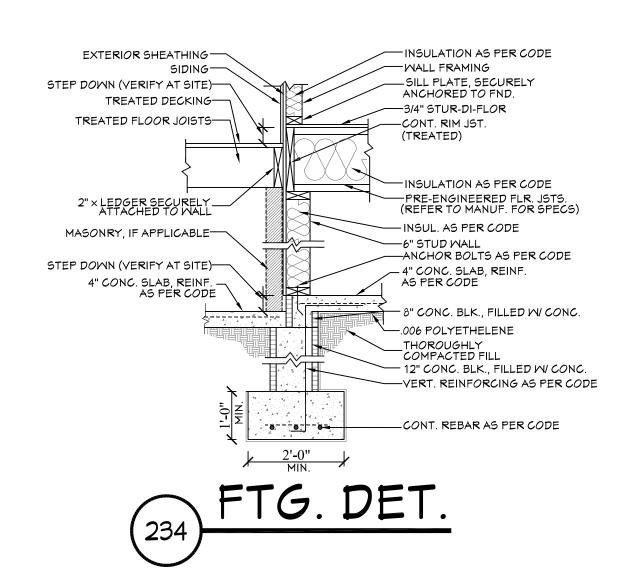


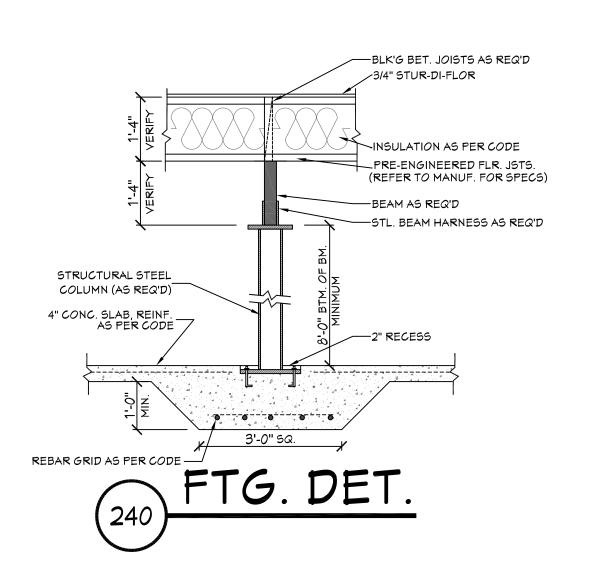


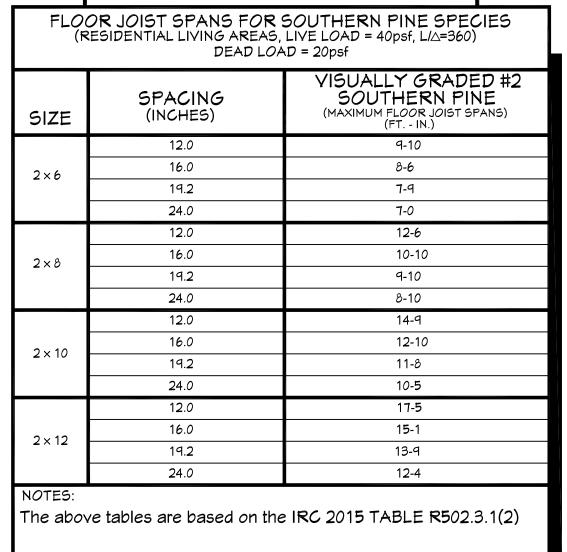






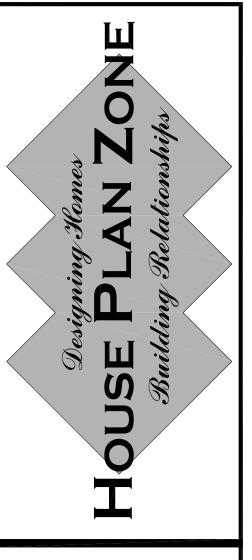






FLOOR.

	BASEMENT FOUNDATION NOTES:
R SOUTHERN PINE SPECIES AS, LIVE LOAD = 40psf, L/\(\triangle = 360\) COAD = 20psf	1. ALL FOOTING SIZES AND LOCATIONS TO BE VERIFIED BY A LICENSED STRUCTURAL ENGINEER.
VISUALLY GRADED #2 SOUTHERN PINE (MAXIMUM FLOOR JOIST SPANS) (FT IN.)	2. CONTRACTOR TO ADAPT PLANS AS REQUIRED TO MEET ALL APPLICABLE CODES AT SITE.
9-10 8-6 7-9 7-0	3. CONTRACTOR SHALL VERIFY ALL DIMENSIONS WITH FLOOR PLAN PRIOR TO CONSTRUCTION AND MAKE ANY NECESSARY ADJUSTMENTS.
12-6 10-10 9-10 8-10	4. CONTRACTOR TO PROVIDE WATERPROOFING AS REQUIRED TO MEET ALL APPLICABLE CODES AND TYPICAL BUILDING PRACTICES.
14-9 12-10 11-8 10-5	5. CONCRETE SLABS TO BE 4" (3000 psi MIN.), REINFORCED AS PER CODE OR AS DETERMINED BY LICENSED ENGINEER.
17-5 15-1 13-9	6. CONTRACTOR TO PROVIDE ADEQUATE DRAINAGE BASED ON EXISTING SITE CONDITIONS. VERIFY w/LOCAL CODES.
12-4	7. REFER TO FLOOR JOIST MANUFACTURER FOR JOIST SIZING AND SPACING, CROSS



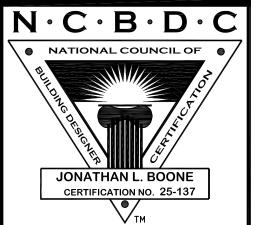
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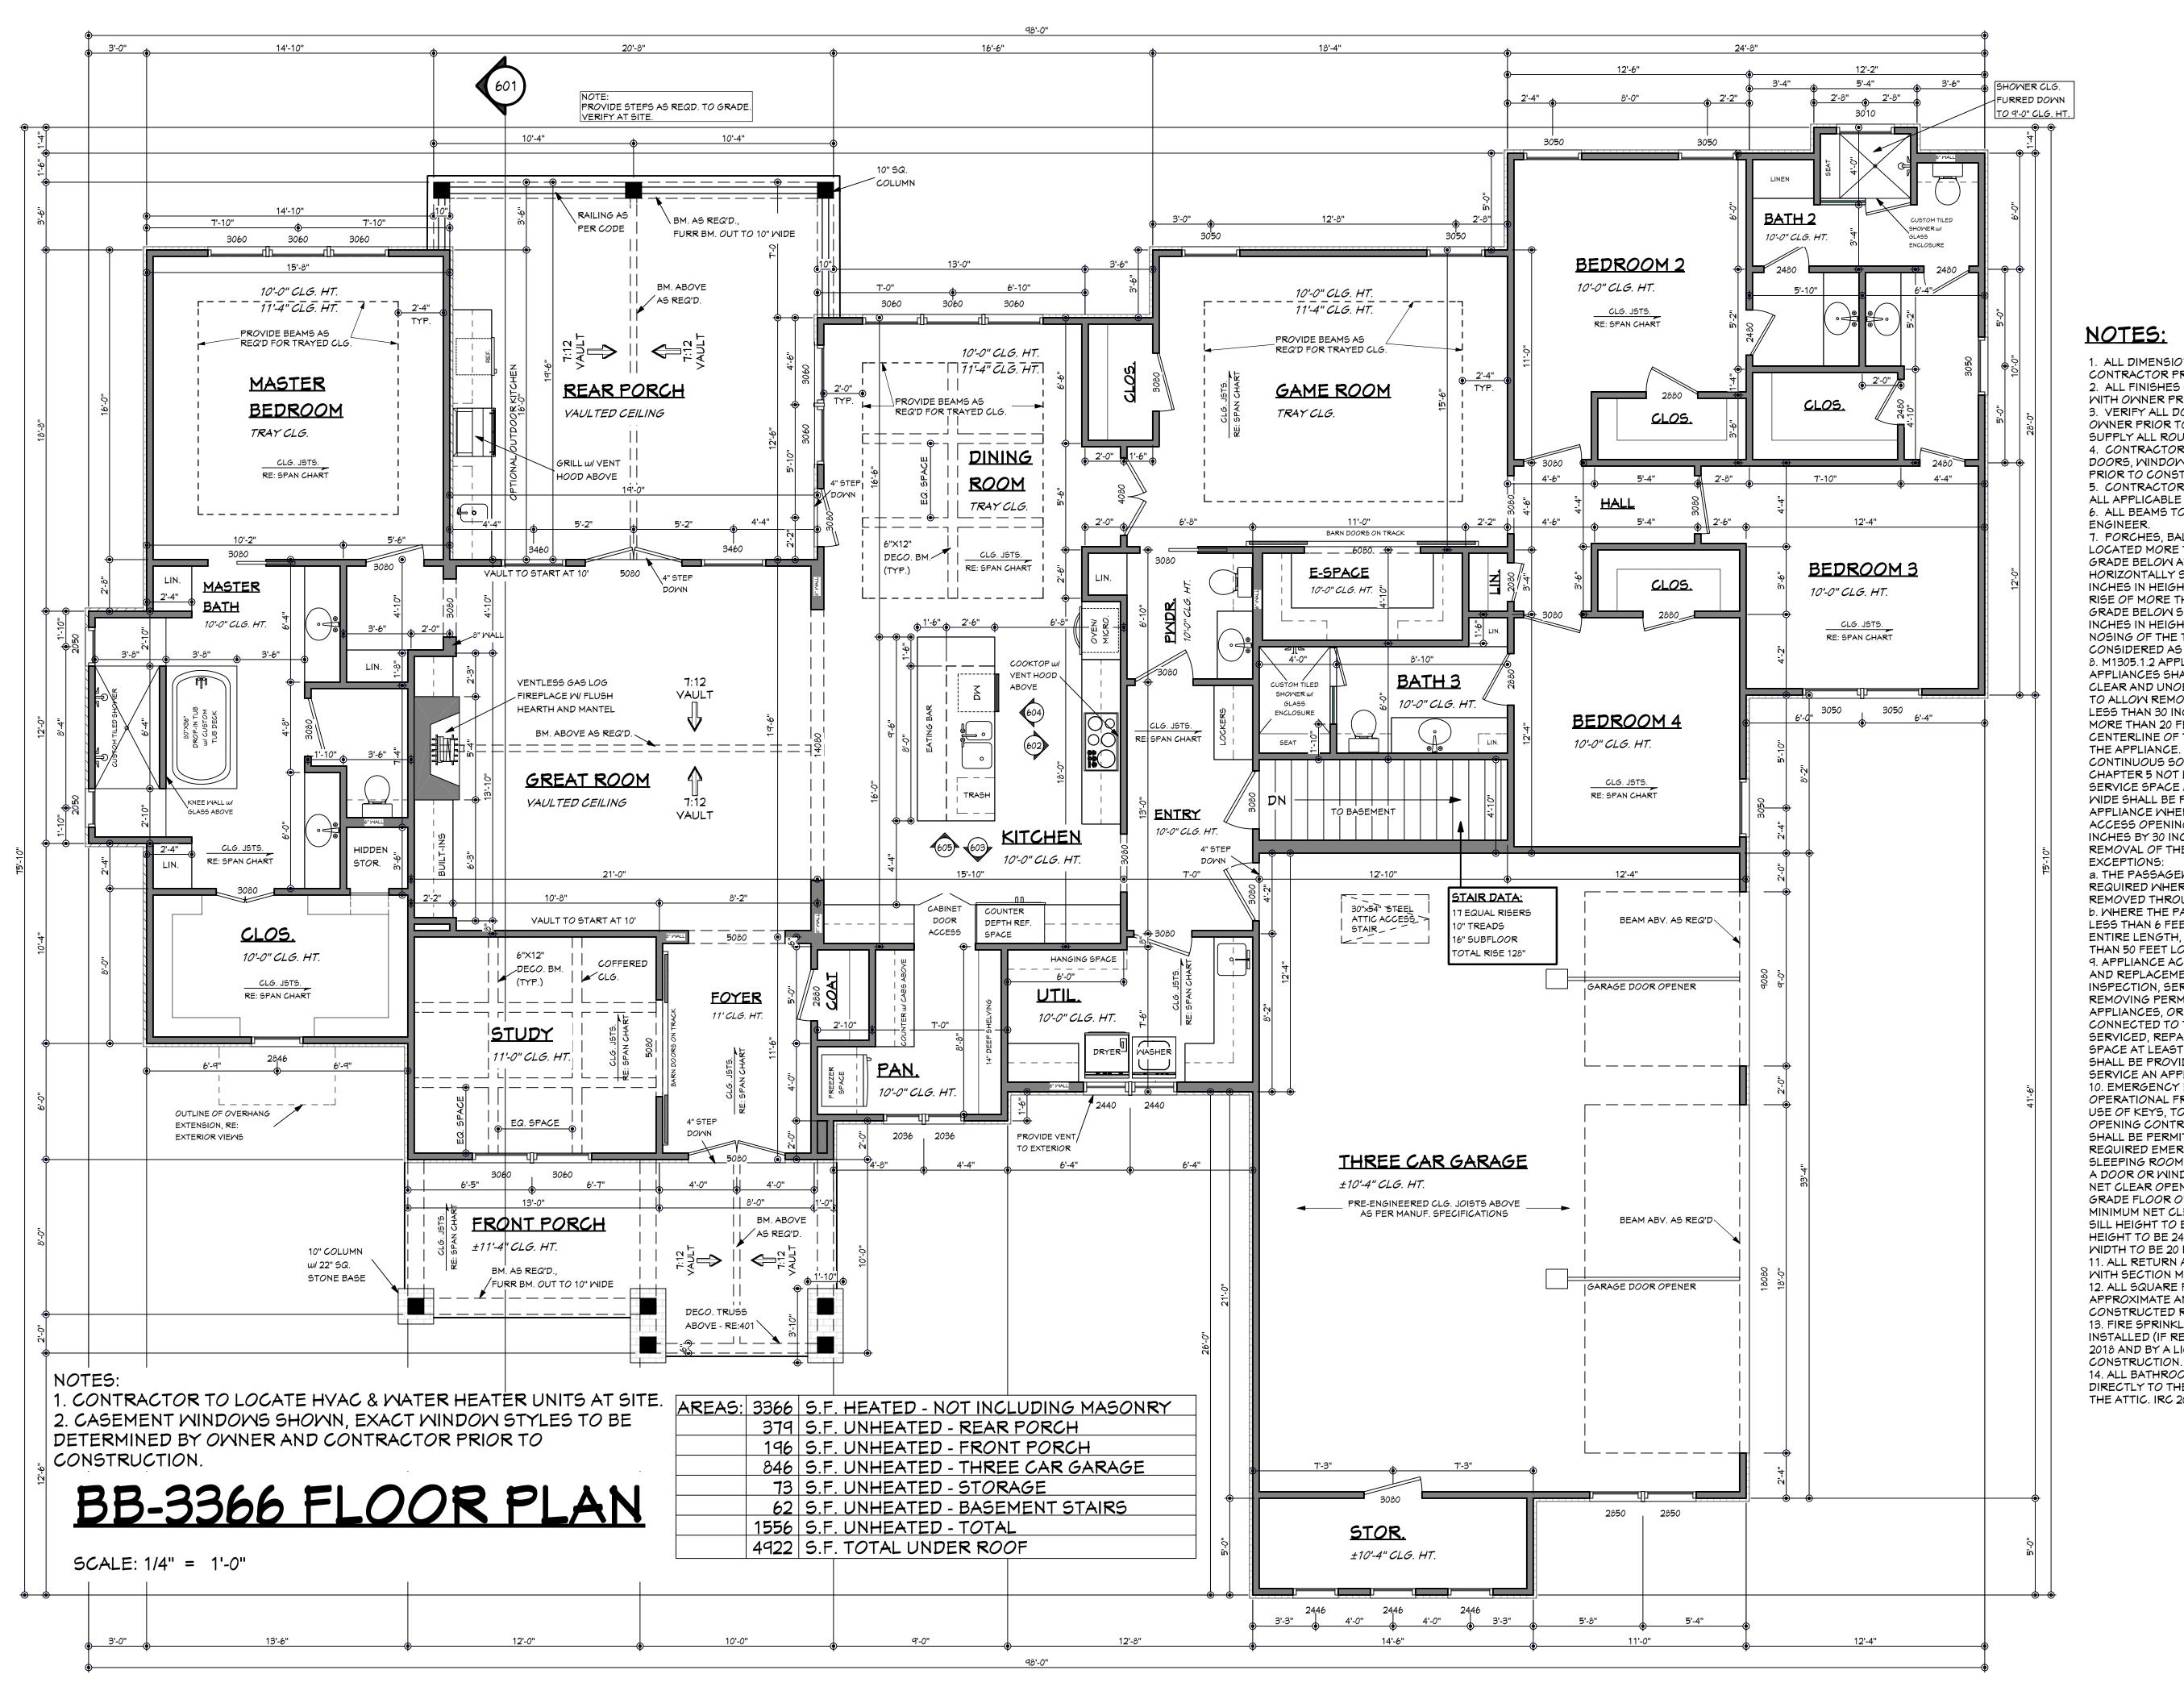
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Date: 03.07.19

J.A.L. Plan number:

Drawn By:

Project Name:



NOTES:

1. ALL DIMENSIONS & SITE CONDITIONS TO BE VERIFIED BY CONTRACTOR PRIOR TO CONSTRUCTION.

2. ALL FINISHES (INTERIOR & EXTERIOR) TO BE VERIFIED WITH OWNER PRIOR TO CONSTRUCTION. 3. VERIFY ALL DOOR AND WINDOW STYLES AND SIZES WITH OWNER PRIOR TO CONSTRUCTION. MANUFACTURER TO SUPPLY ALL ROUGH OPENING SIZES.

4. CONTRACTOR TO VERIFY ALL CLEARANCES OF ALL DOORS, WINDOWS AND OTHER ITEMS THAT ARE CRITICAL, PRIOR TO CONSTRUCTION. 5. CONTRACTOR TO ADAPT PLANS AS REQUIRED TO MEET

ALL APPLICABLE CODES AT SITE. 6. ALL BEAMS TO BE SIZED BY A LICENSED STRUCTURAL

ENGINEER. 7. PORCHES, BALCONIES OR RAISED FLOOR SURFACES LOCATED MORE THAN 30 INCHES ABOVE THE FLOOR OR GRADE BELOW AT ANY POINT WITHIN 36 INCHES

HORIZONTALLY SHALL HAVE GUARDS NOT LESS THAN 36 INCHES IN HEIGHT. OPEN SIDES OF STAIRS WITH A TOTAL RISE OF MORE THAN 30 INCHES ABOVE THE FLOOR OR GRADE BELOW SHALL HAVE GUARDS NOT LESS THAN 34 INCHES IN HEIGHT MEASURED VERTICALLY FROM THE NOSING OF THE TREADS. INSECT SCREENING SHALL NOT BE CONSIDERED AS A GUARD. IRC 2018, R312.1.1 & R312.1.2 8. M1305.1.2 APPLIANCES IN ATTICS. ATTICS CONTAINING APPLIANCES SHALL BE PROVIDED WITH AN OPENING AND A CLEAR AND UNOBSTRUCTED PASSAGEWAY LARGE ENOUGH TO ALLOW REMOVAL OF THE LARGEST APPLIANCE, BUT NOT LESS THAN 30 INCHES HIGH AND 22 INCHES MIDE AND NOT MORE THAN 20 FEET LONG MEASURED ALONG THE CENTERLINE OF THE PASSAGEWAY FROM THE OPENING TO THE APPLIANCE. THE PASSAGEWAY SHALL HAVE CONTINUOUS SOLID FLOORING IN ACCORDANCE WITH CHAPTER 5 NOT LESS THAN 24 INCHES WIDE. A LEVEL SERVICE SPACE AT LEAST 30 INCHES DEEP AND 30 INCHES WIDE SHALL BE PRESENT ALONG ALL SIDES OF THE APPLIANCE WHERE ACCESS IS REQUIRED. THE CLEAR ACCESS OPENING DIMENSIONS SHALL BE A MINIMUM OF 20 INCHES BY 30 INCHES, AND LARGE ENOUGH TO ALLOW REMOVAL OF THE LARGEST APPLIANCE.

a. THE PASSAGEWAY AND LEVEL SERVICE SPACE ARE NOT REQUIRED WHERE THE APPLIANCE CAN BE SERVICED AND REMOVED THROUGH THE REQUIRED OPENING. b. WHERE THE PASSAGEWAY IS UNOBSTRUCTED AND NOT LESS THAN 6 FEET HIGH AND 22 INCHES WIDE FOR ITS ENTIRE LENGTH, THE PASSAGEWAY SHALL BE NOT MORE THAN 50 FEET LONG.

9. APPLIANCE ACCESS FOR INSPECTION SERVICE, REPAIR AND REPLACEMENT. APPLIANCES SHALL BE ACCESSIBLE FOR INSPECTION, SERVICE, REPAIR AND REPLACEMENT WITHOUT REMOVING PERMANENT CONSTRUCTION, OTHER APPLIANCES, OR ANY OTHER PIPING OR DUCTS NOT CONNECTED TO THE APPLIANCE BEING INSPECTED, SERVICED, REPAIRED OR REPLACED. A LEVEL WORKING SPACE AT LEAST 30 INCHES DEEP AND 30 INCHES WIDE SHALL BE PROVIDED IN FRONT OF THE CONTROL SIDE TO SERVICE AN APPLIANCE. M1305.1.1

10. EMERGENCY ESCAPE AND RESCUE OPENINGS SHALL BE OPERATIONAL FROM THE INSIDE OF THE ROOM WITHOUT THE USE OF KEYS, TOOLS OR SPECIAL KNOWLEDGE. WINDOW OPENING CONTROL DEVICES COMPLYING WITH ASTM F 2090 SHALL BE PERMITTED FOR USE ON WINDOWS SERVING AS A REQUIRED EMERGENCY ESCAPE AND RESCUE OPENING. ALL SLEEPING ROOMS TO HAVE AN EXTERIOR ACCESS THROUGH A DOOR OR WINDOW WITH A MINIMUM OF 5.7 SQUARE FEET NET CLEAR OPENING AS PER IRC 2018 R310.2.1. EXCEPTION: GRADE FLOOR OR BELOW GRADE OPENINGS SHALL HAVE A MINIMUM NET CLEAR OPENING OF 5 SQUARE FEET. MAXIMUM SILL HEIGHT TO BE 44 INCHES. MINIMUM NET CLEAR OPENING HEIGHT TO BE 24 INCHES. MINIMUM NET CLEAR OPENING WIDTH TO BE 20 INCHES.

11. ALL RETURN AIR GRILLS ARE TO BE LOCATED TO COMPLY WITH SECTION M1602 OF THE IRC 2018. 12. ALL SQUARE FOOTAGE MEASUREMENTS ARE APPROXIMATE AND MAY DIFFER FROM ACTUAL CONSTRUCTED RESIDENCE OR BUILDING. 13. FIRE SPRINKLER SYSTEM TO BE DESIGNED AND INSTALLED (IF REQUIRED BY LOCAL CODES) AS PER THE IRC 2018 AND BY A LICENSED PROFESSIONAL IN THE AREA OF

14. ALL BATHROOM EXHAUST VENTS SHALL BE VENTED DIRECTLY TO THE EXTERIOR OF THE HOME AND NOT INTO THE ATTIC. IRC 2018, M1505.2

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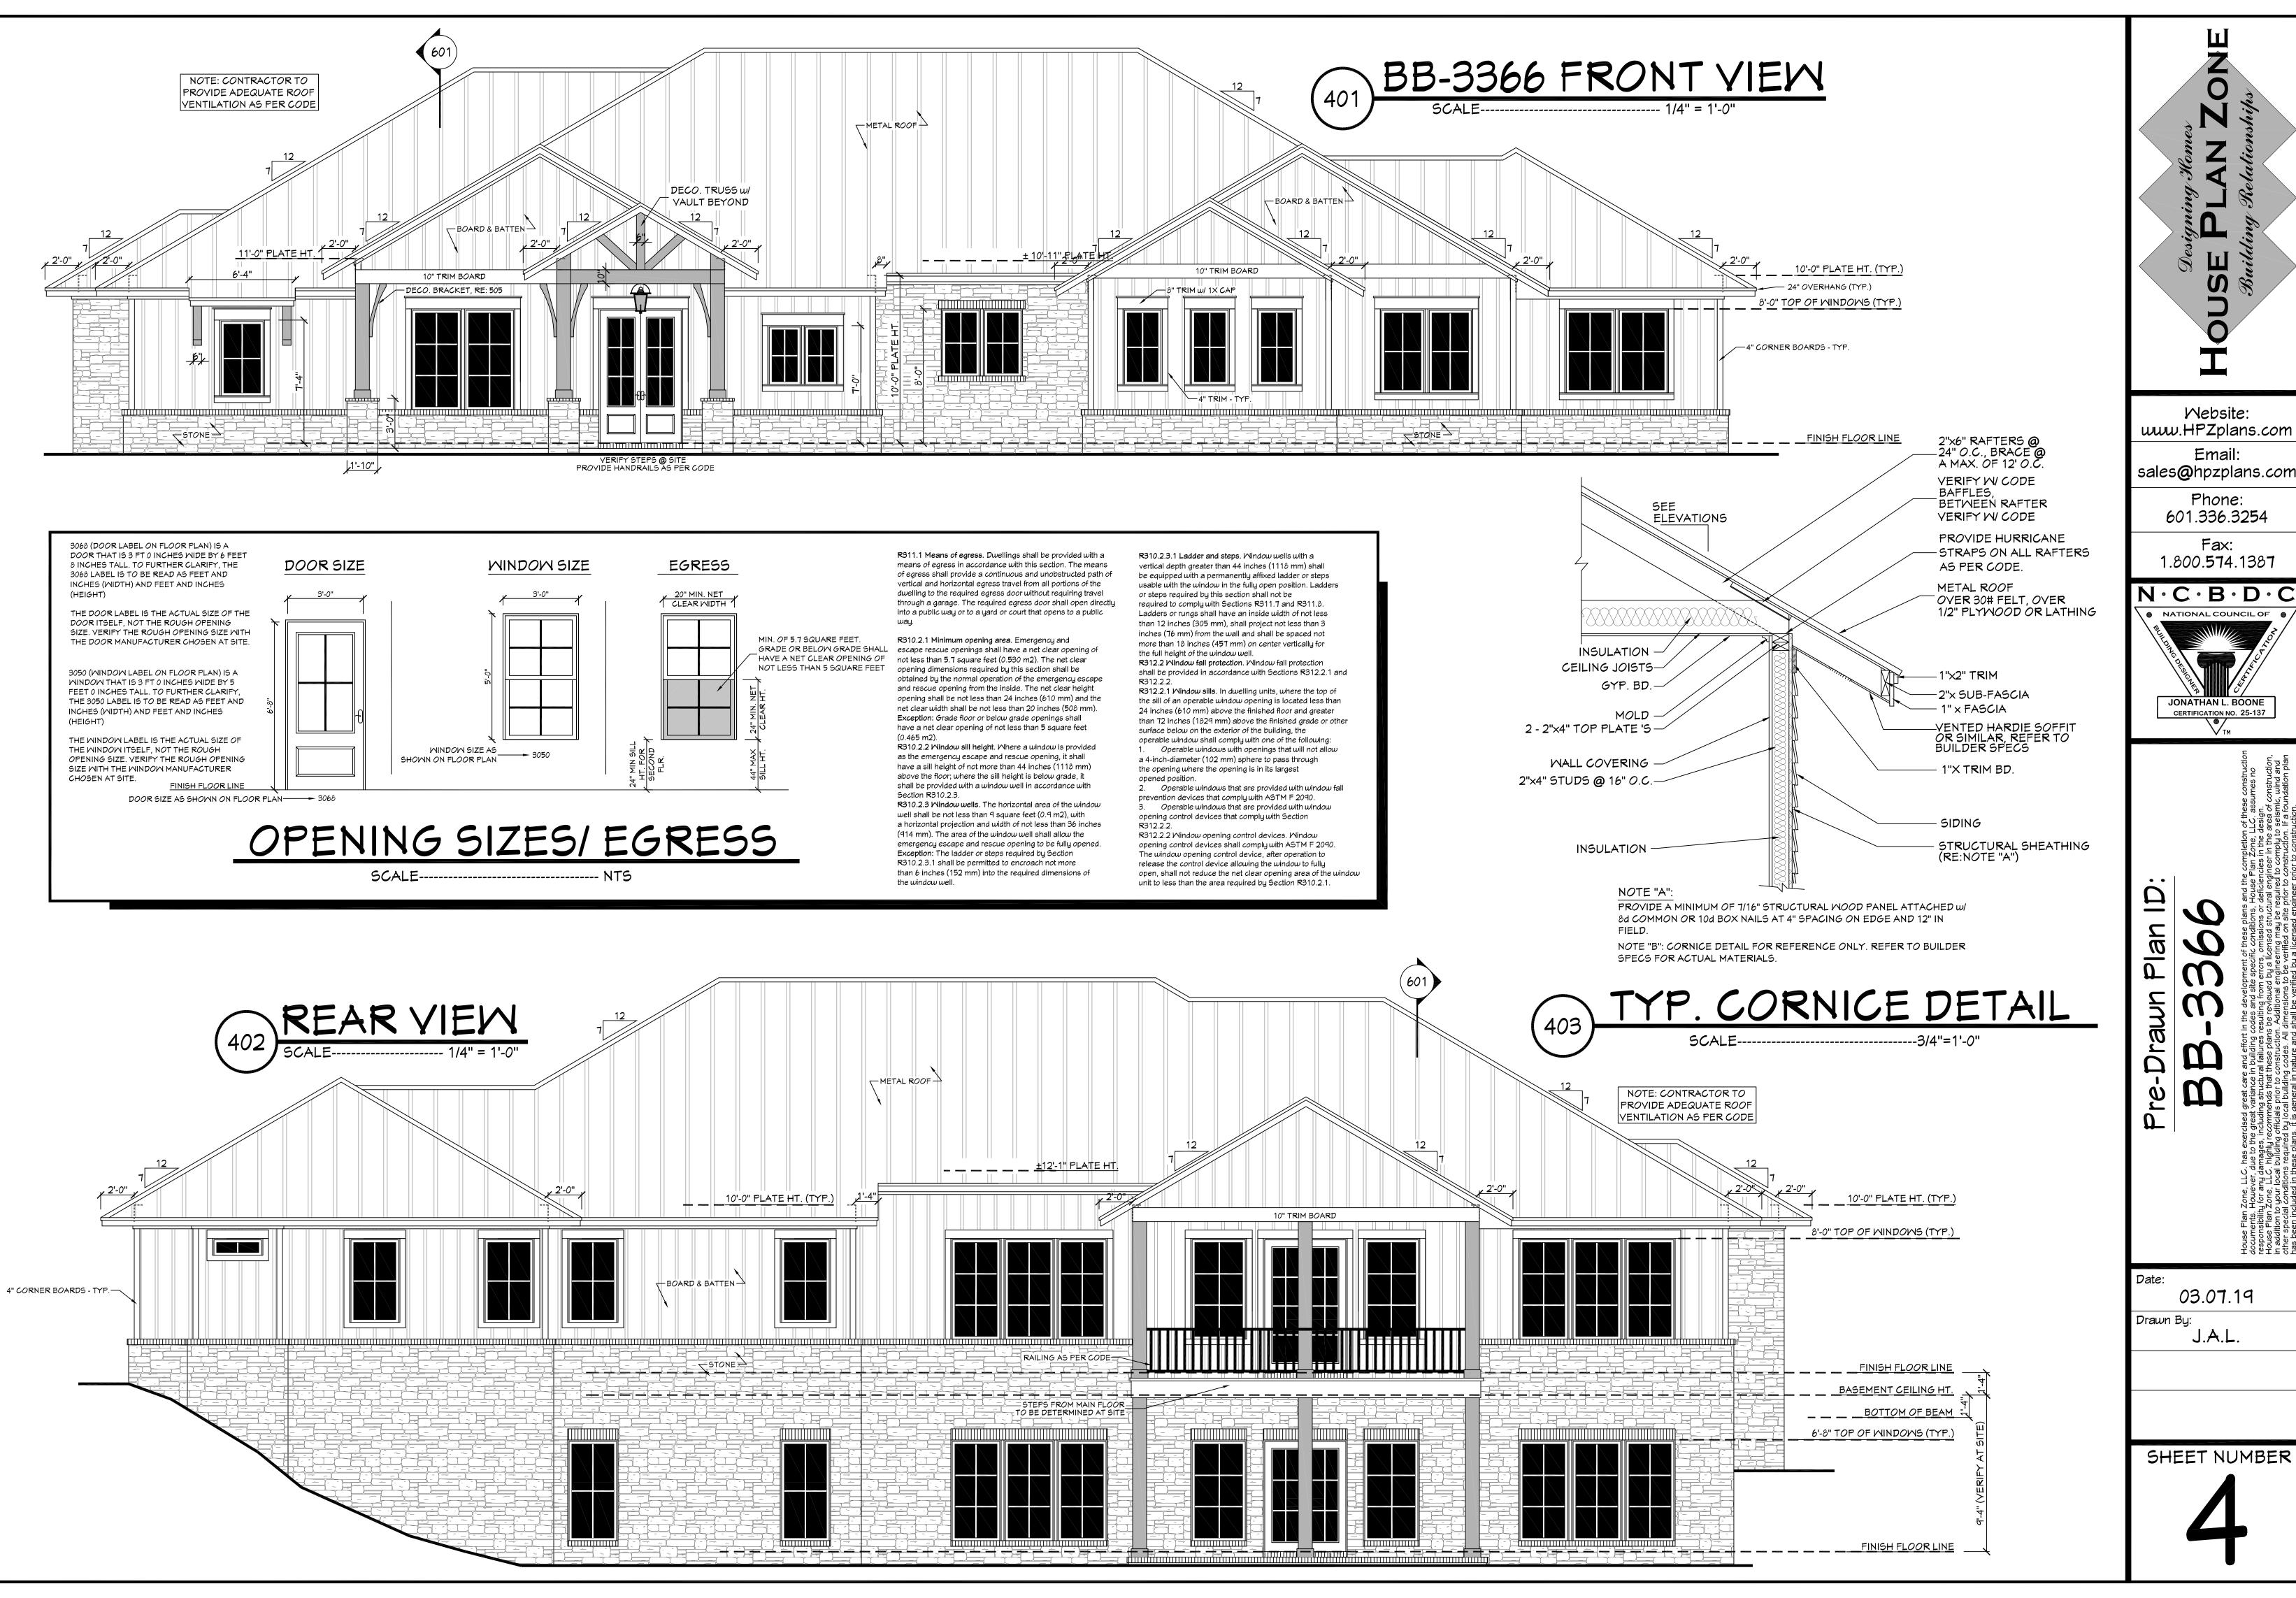
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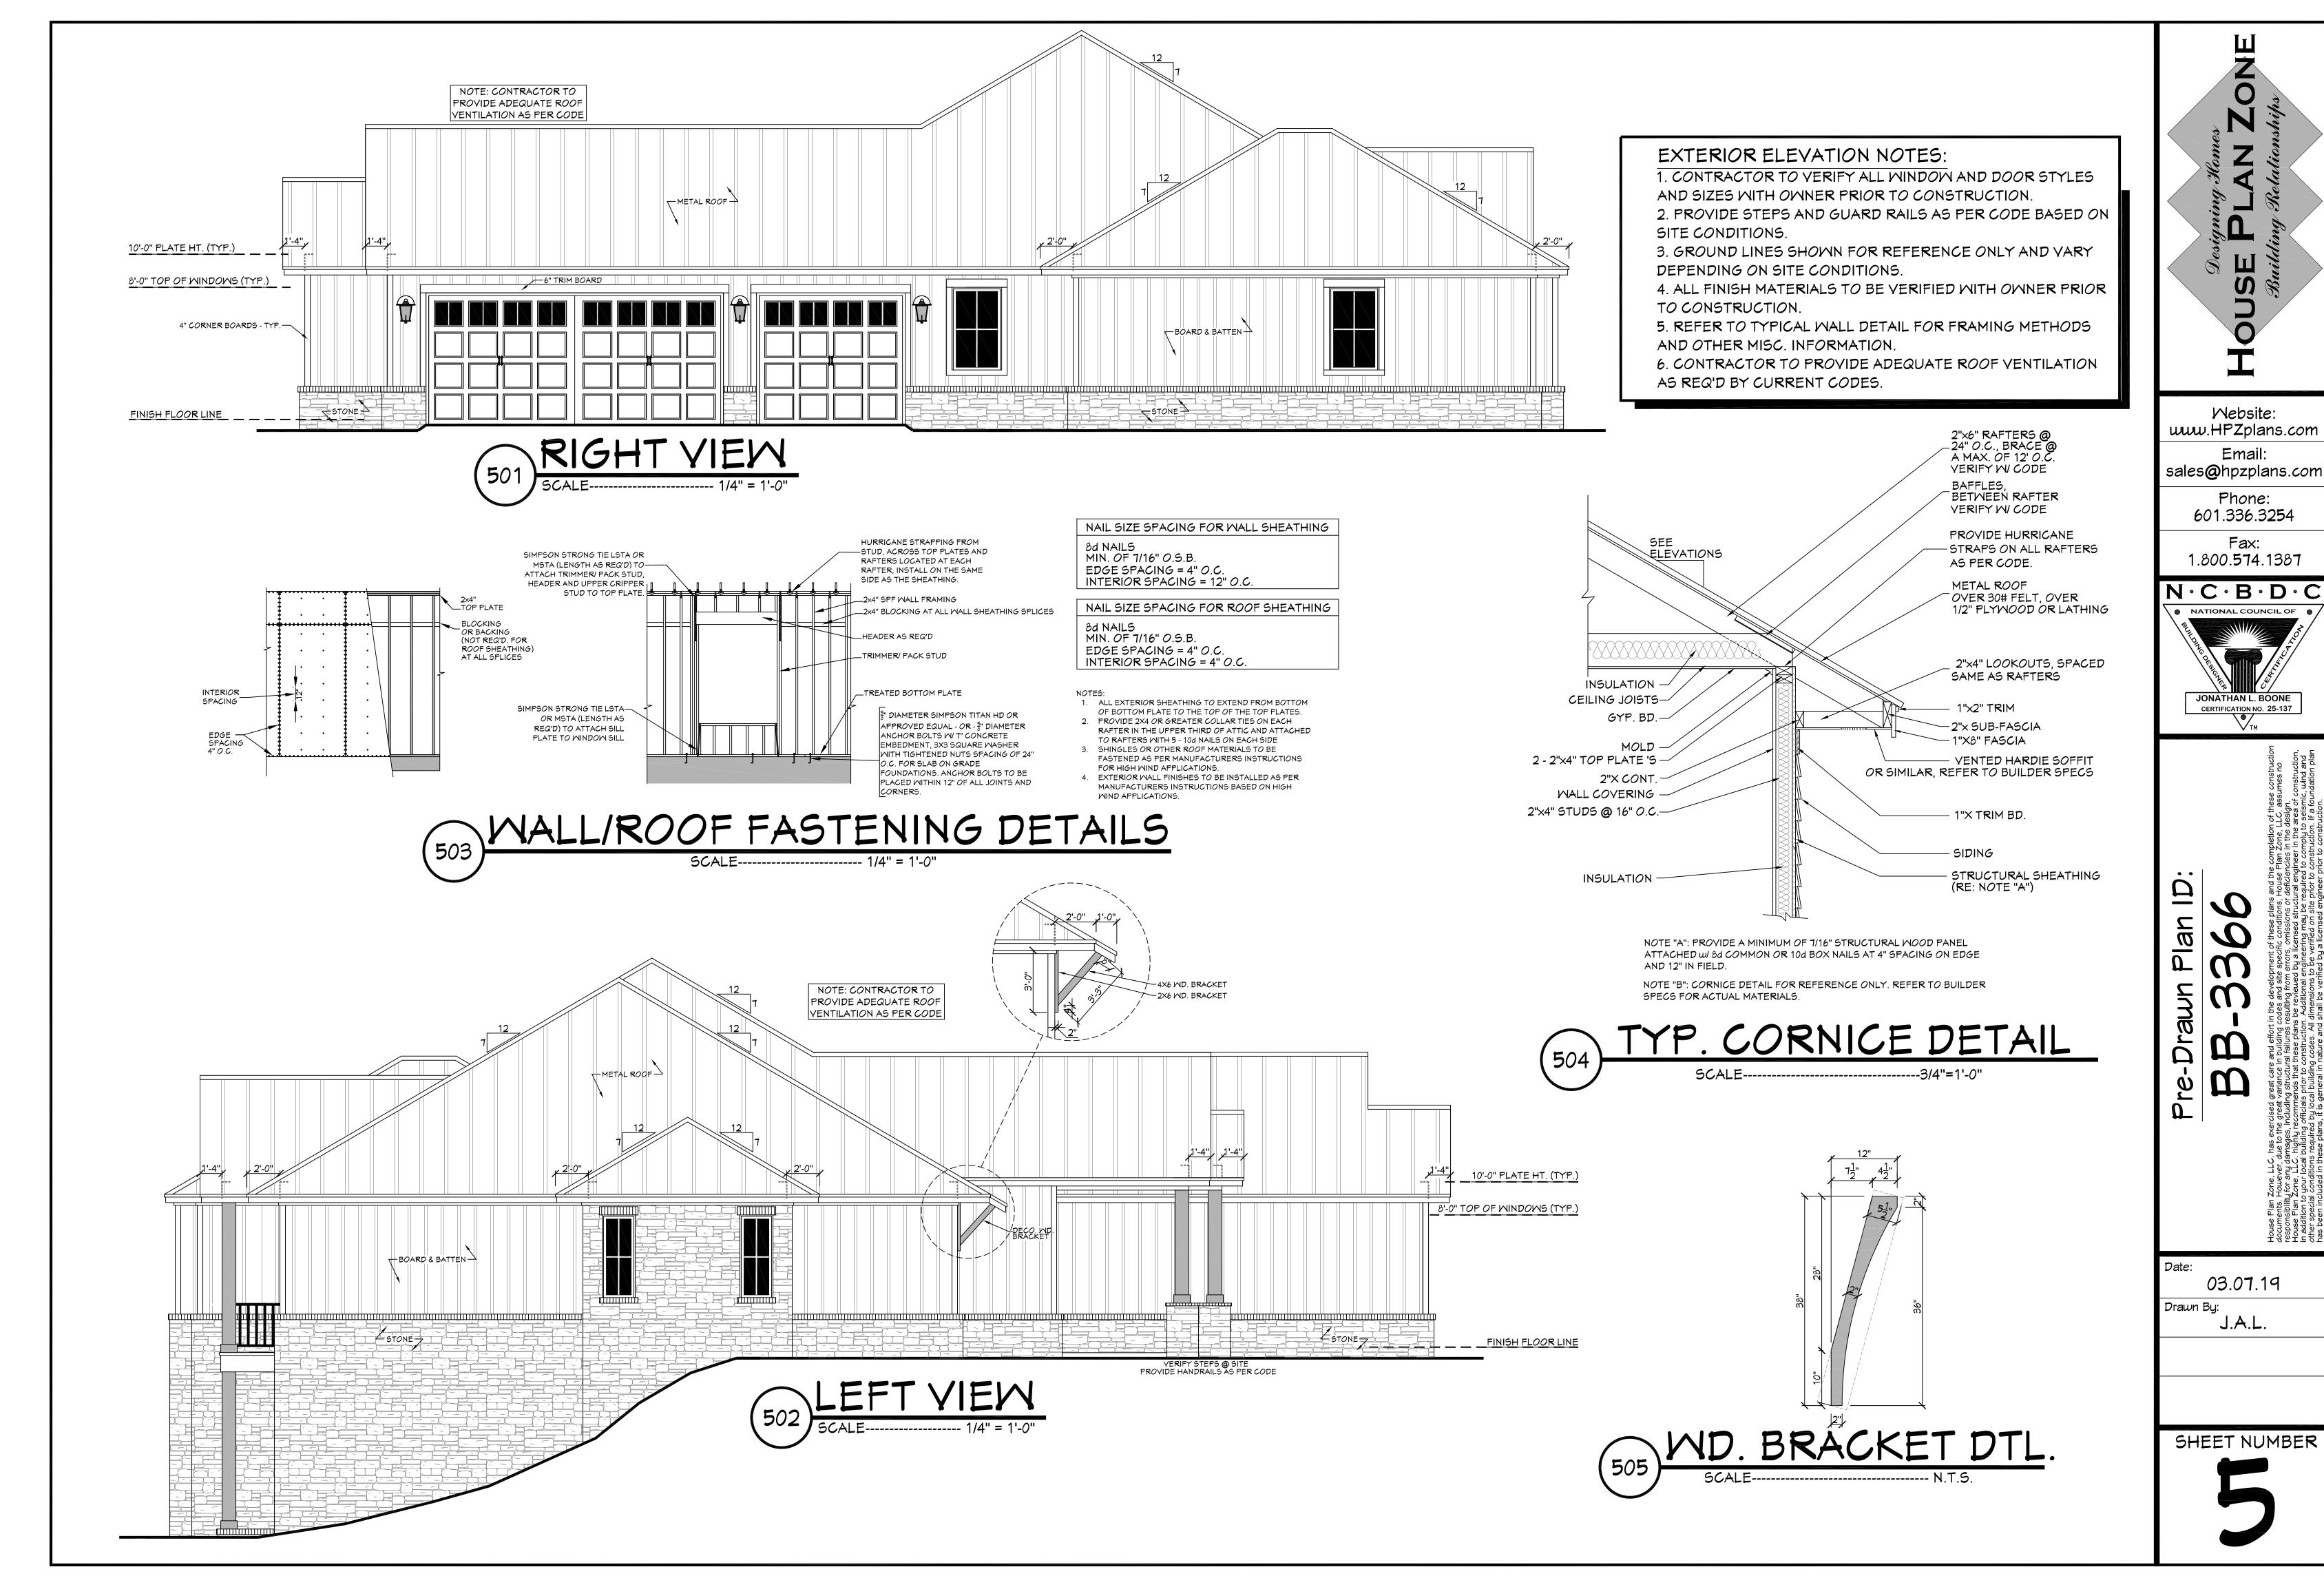
J.A.L.

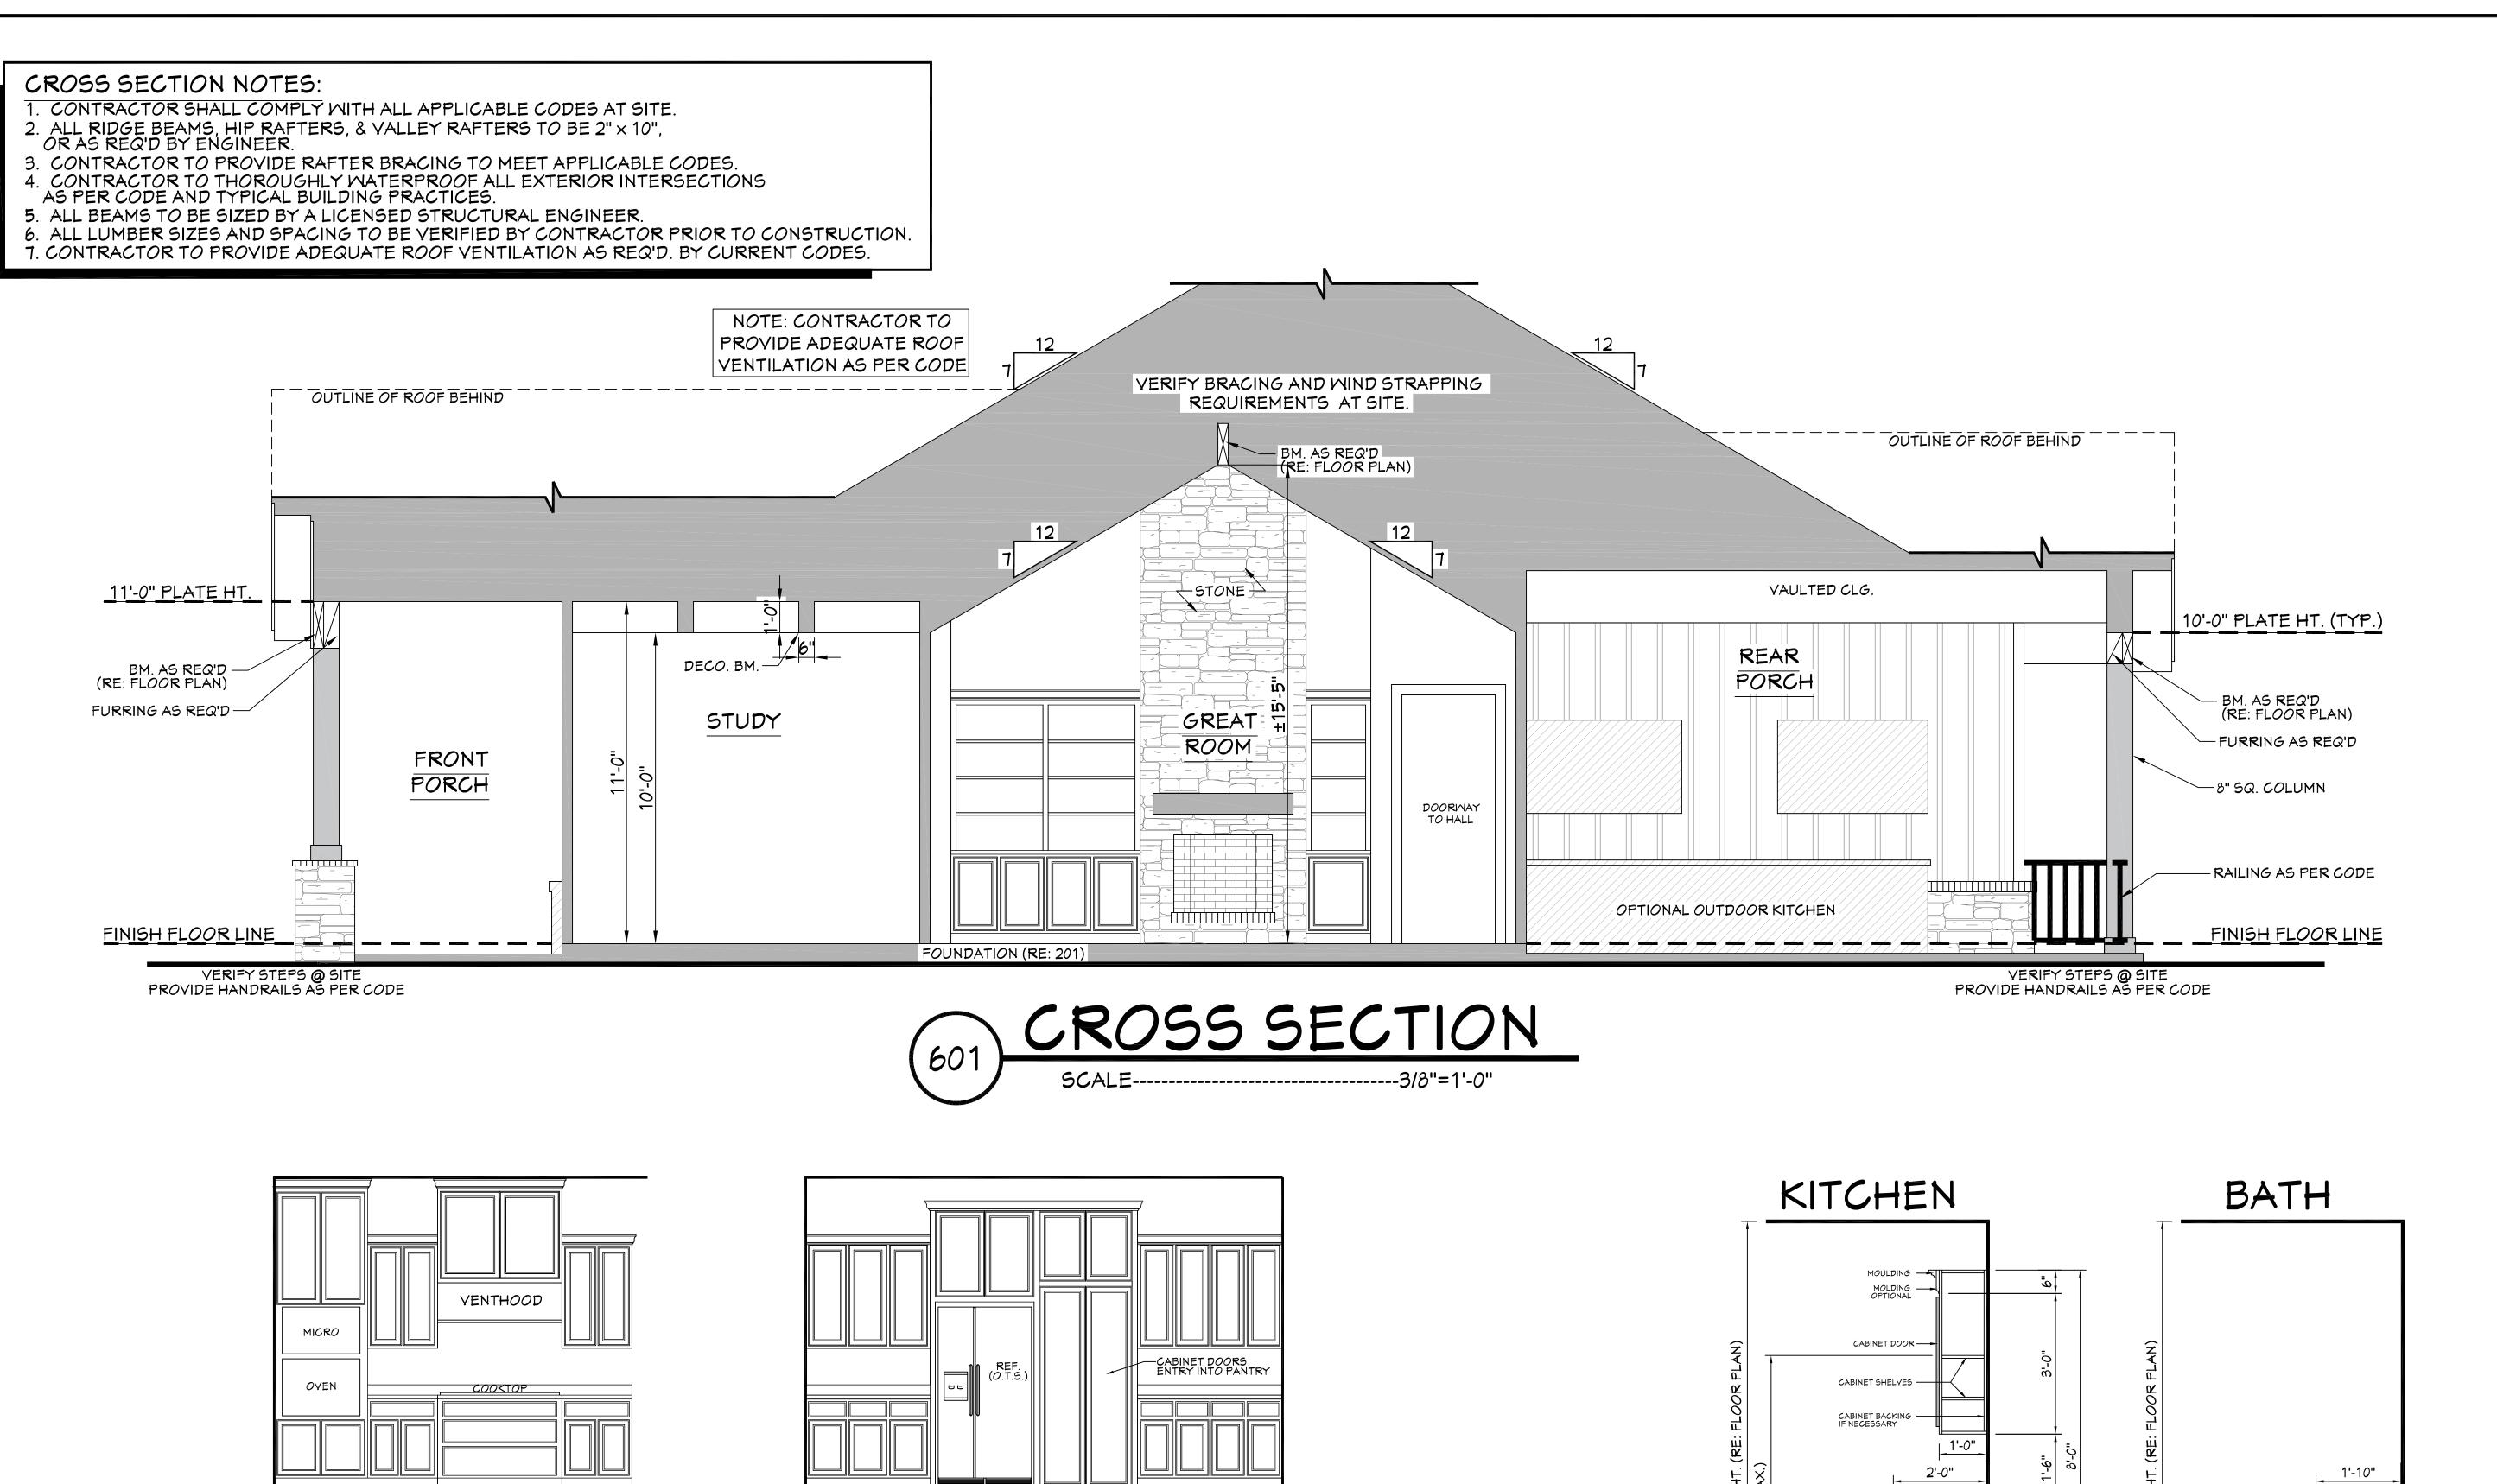
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603 KITCHEN

SCALE-----3/8" = 1'-0"

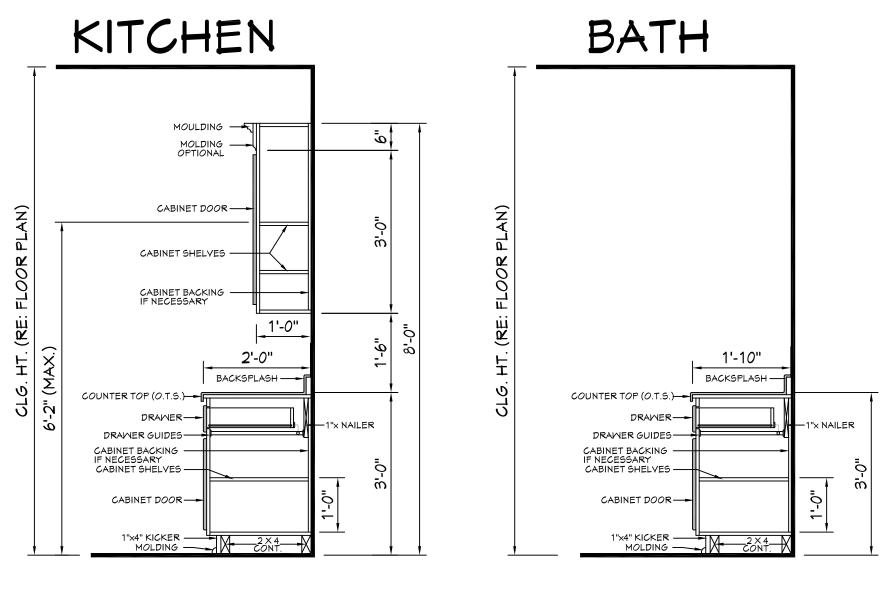
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602) KITCHEN

SCALE------3/8" = 1'-0"

604 KITCHEN

SCALE------3/8" = 1'-0"





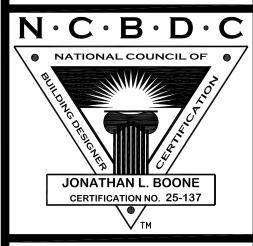
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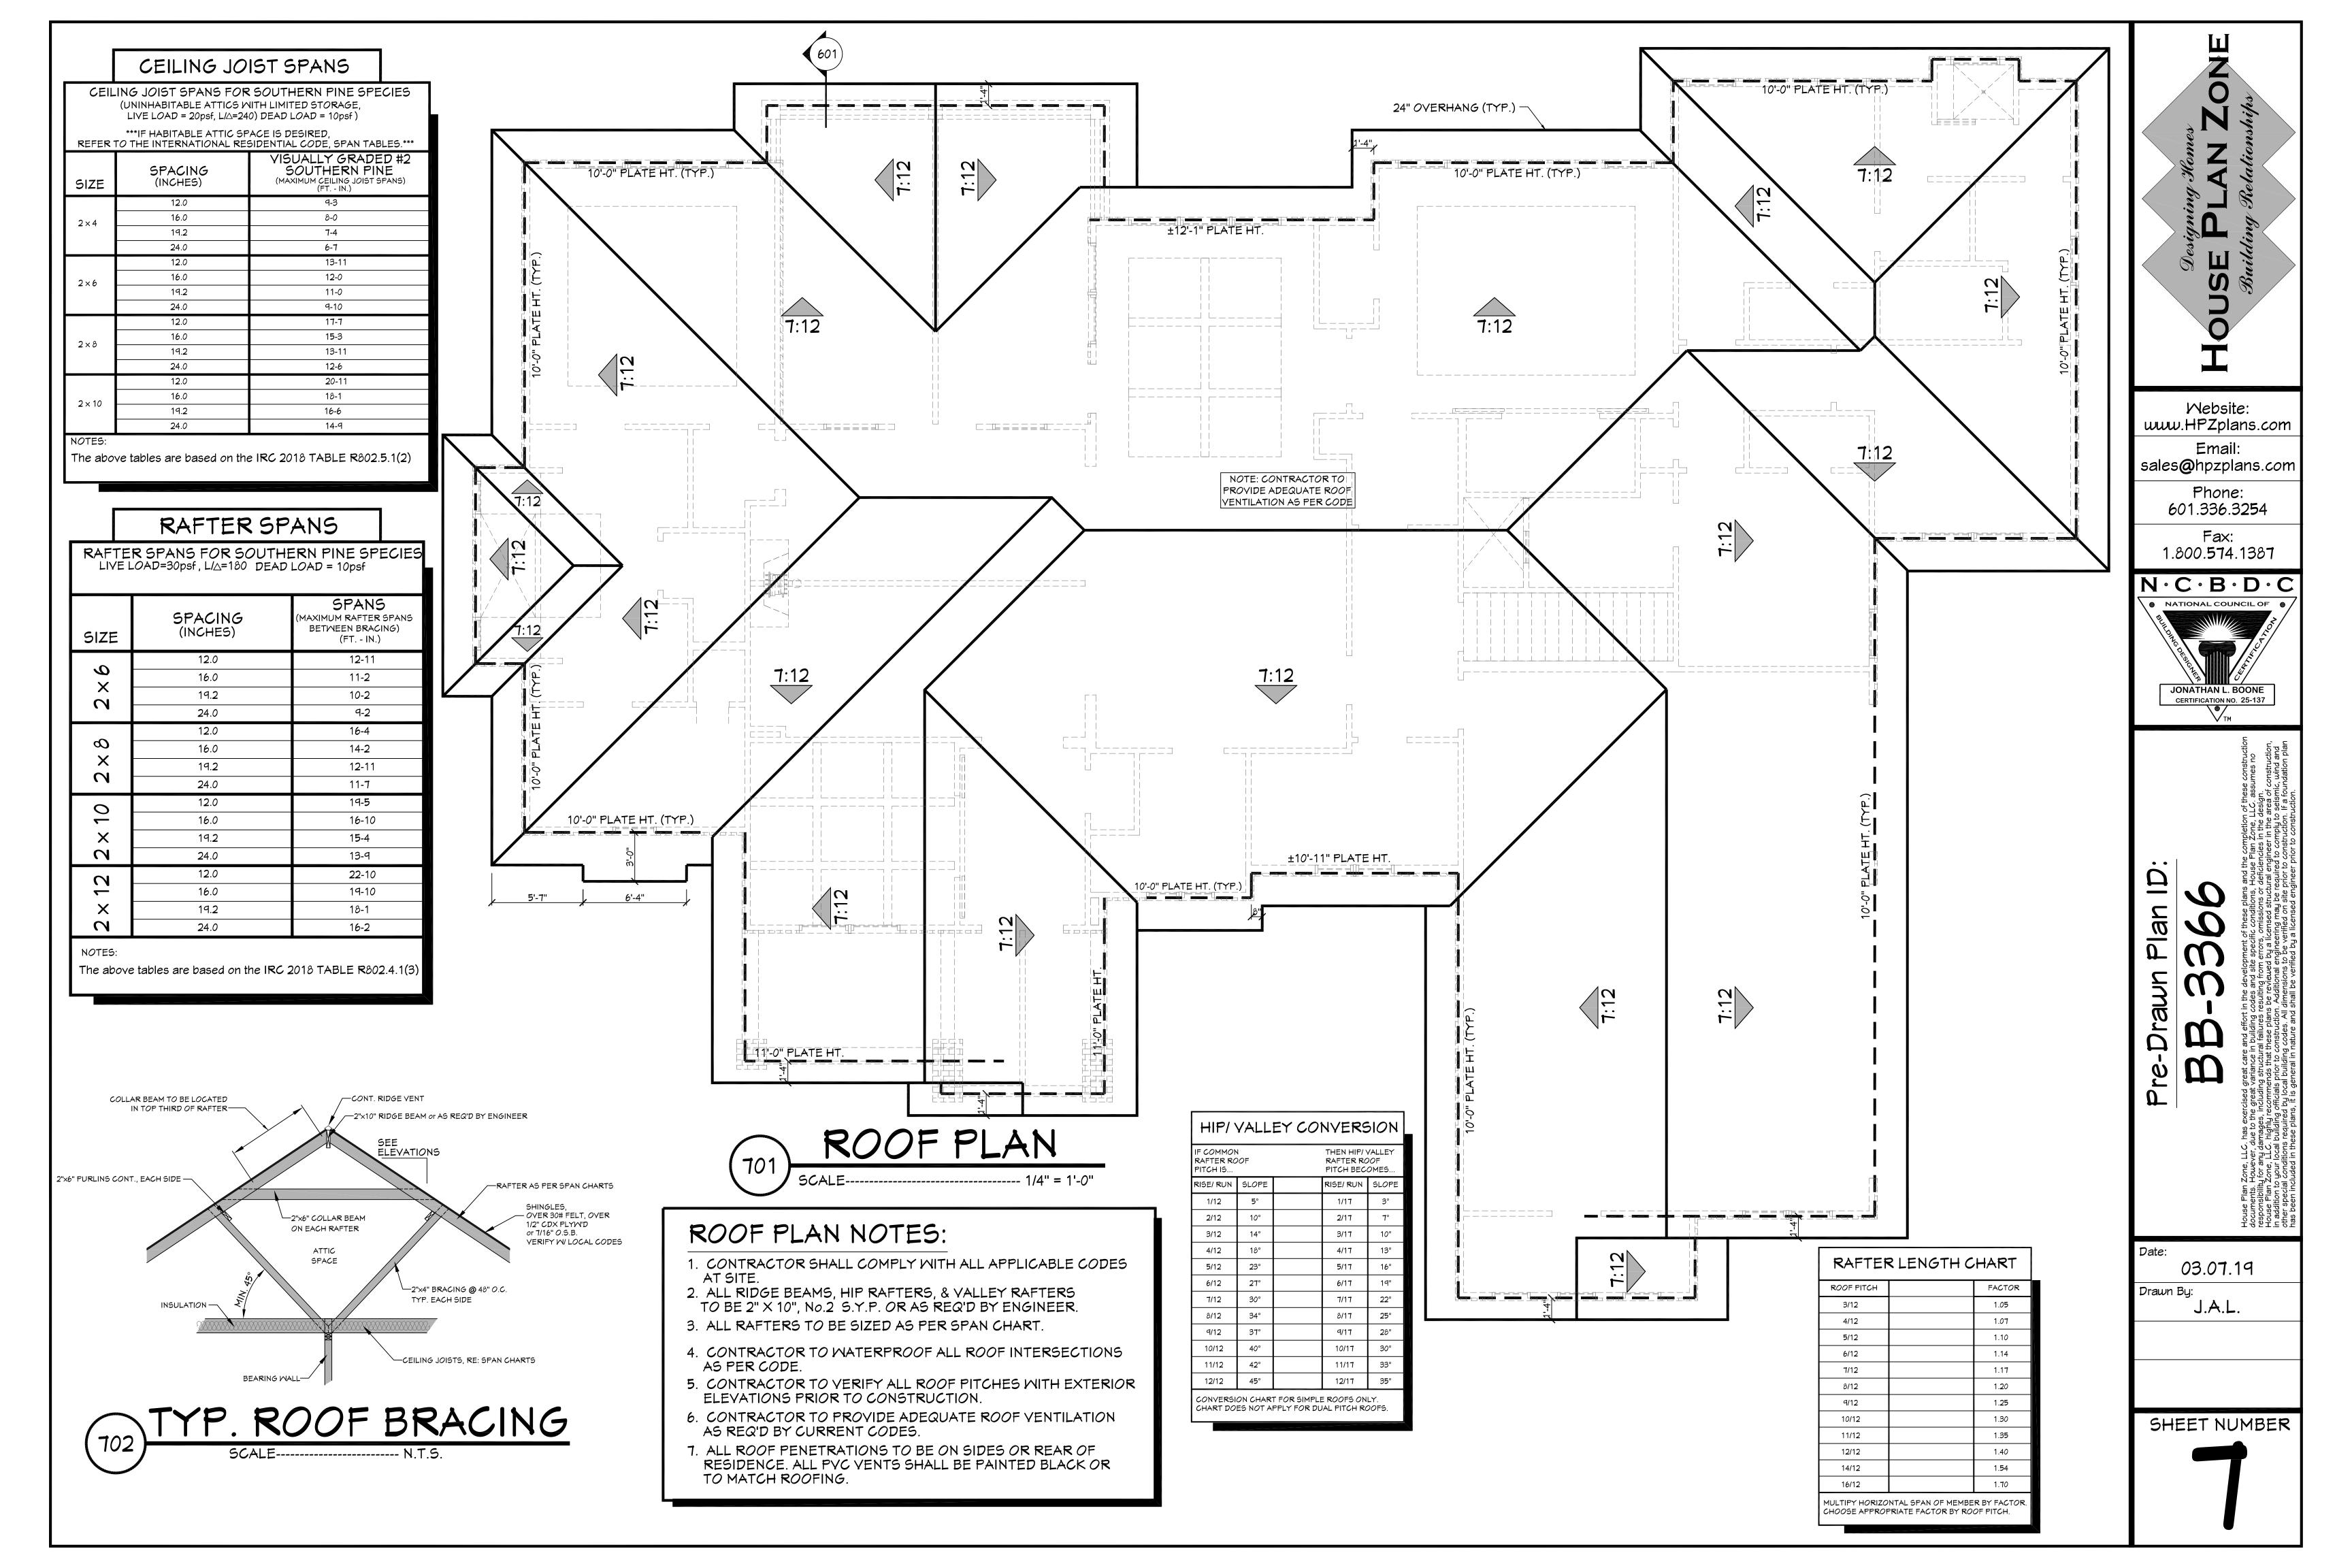
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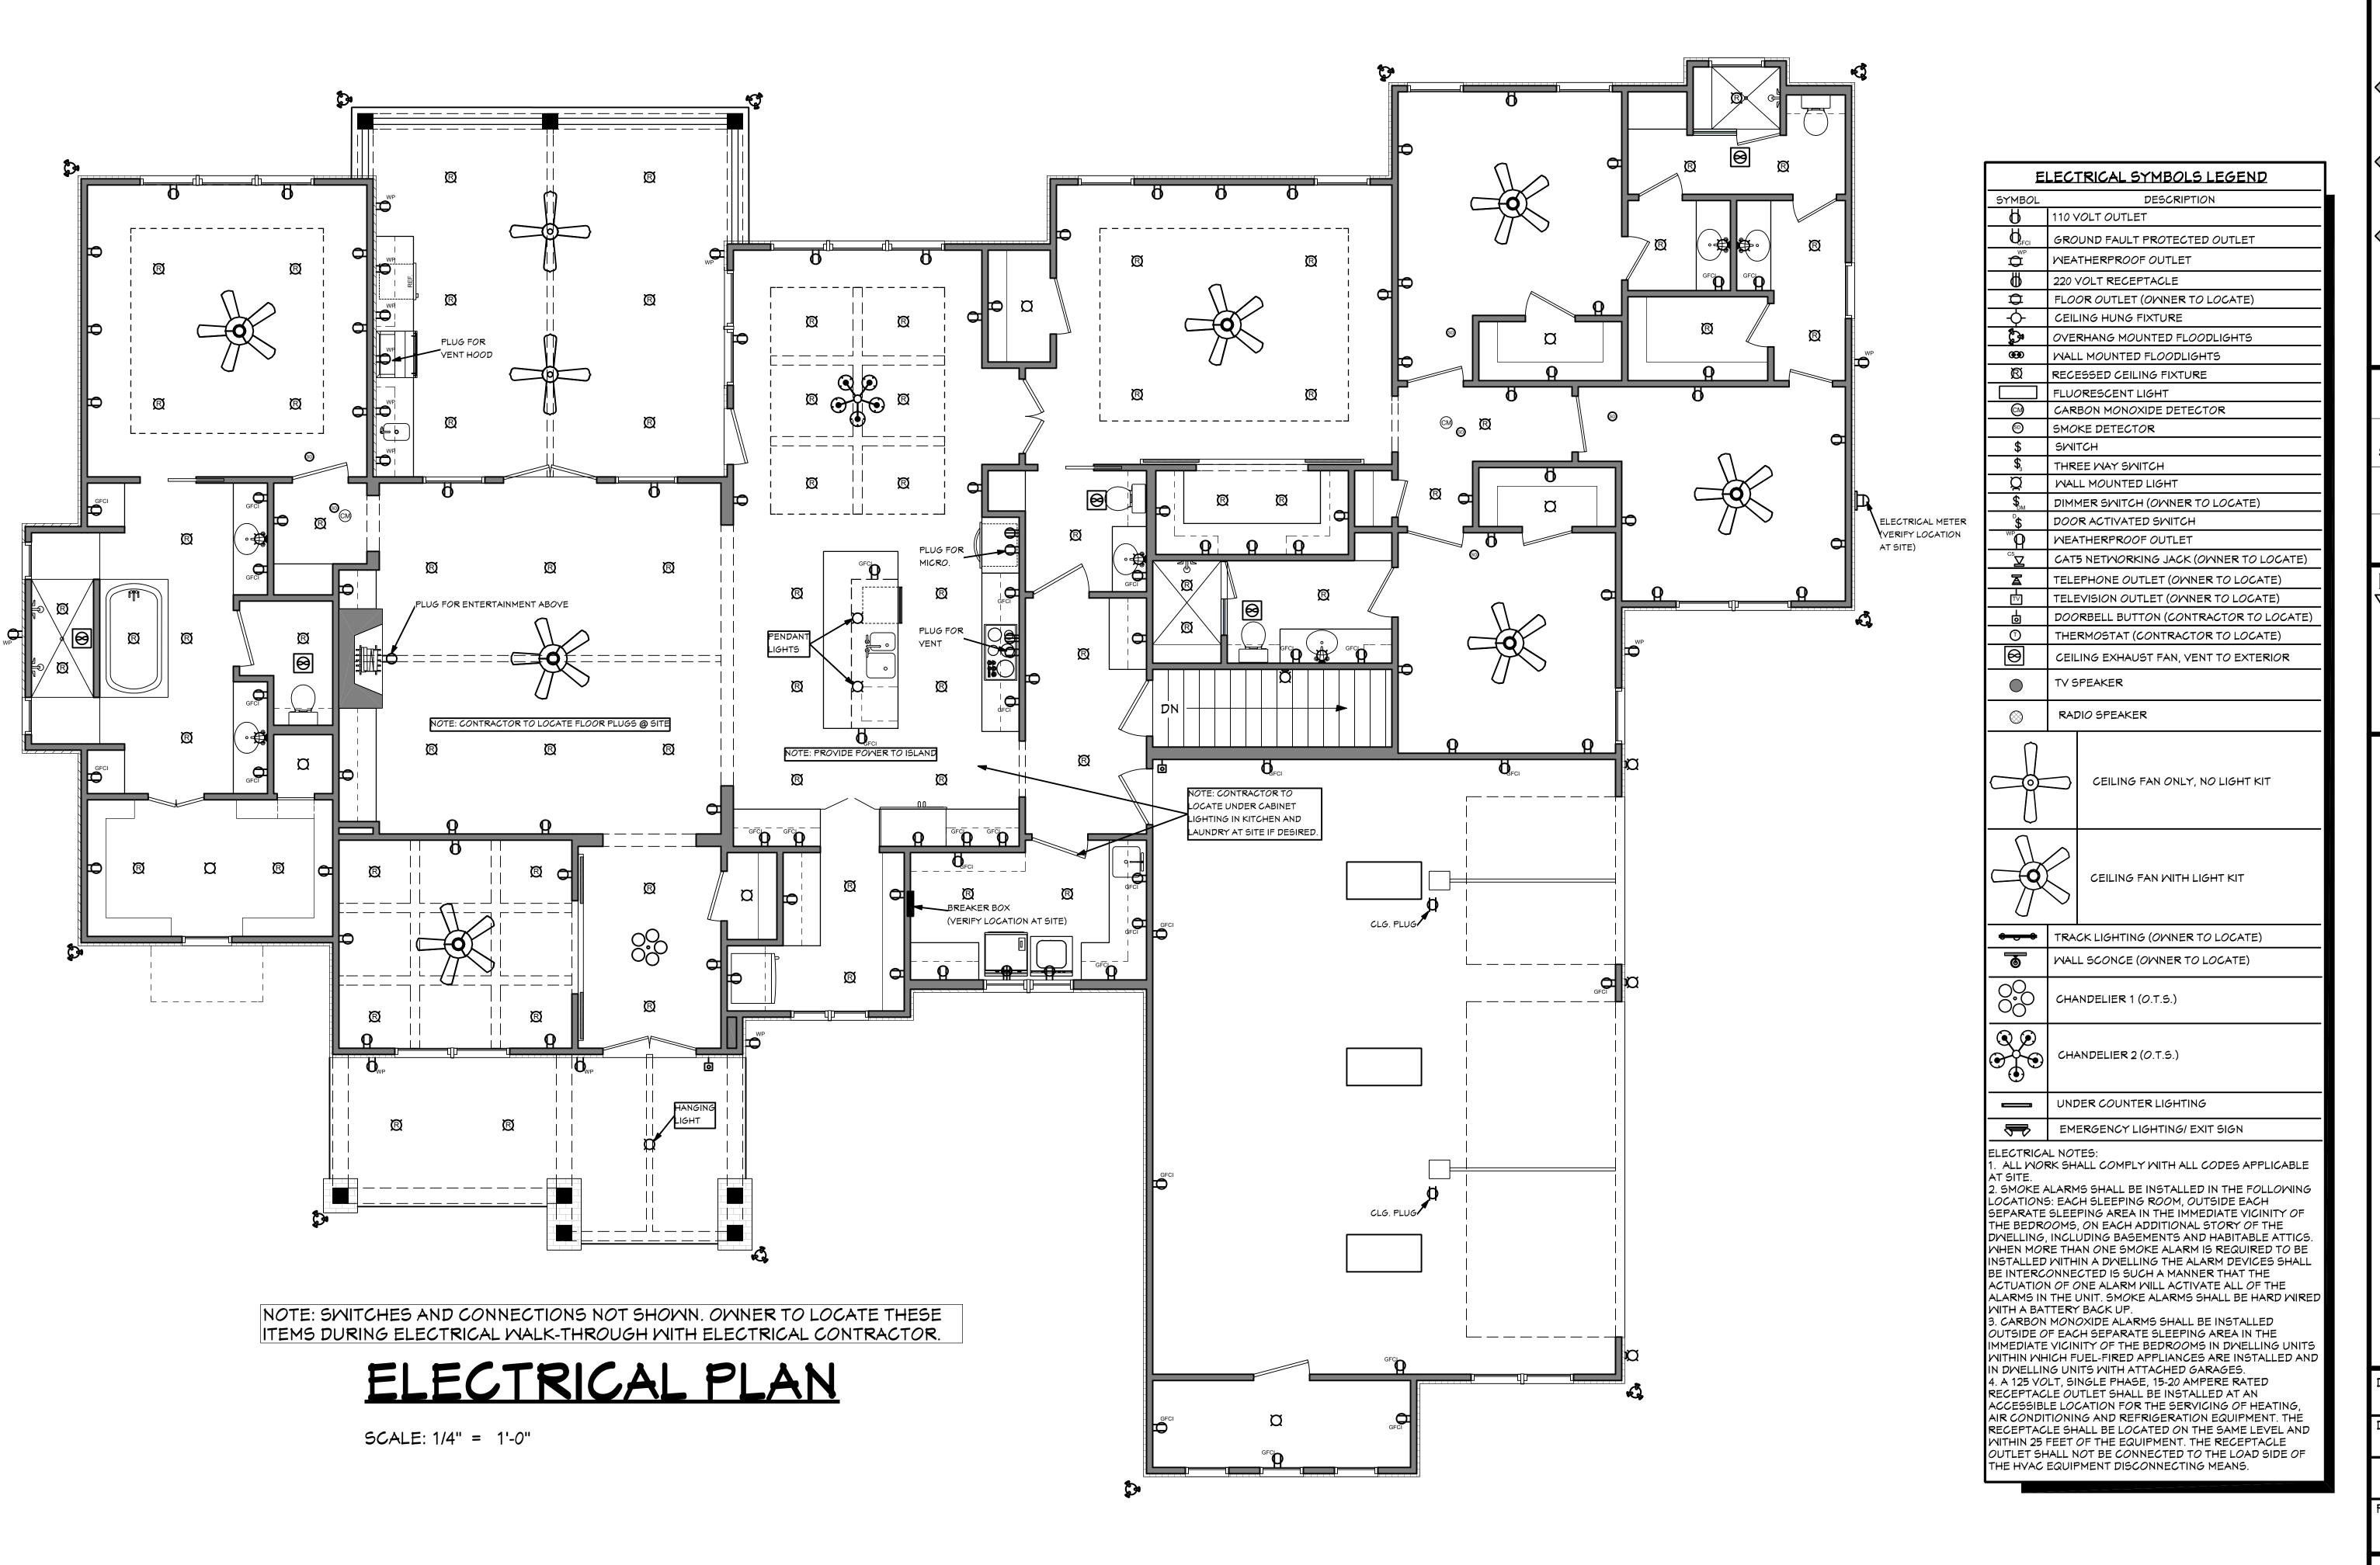


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BB-3;

Date: 03.07.19 Drawn By: J.A.L.







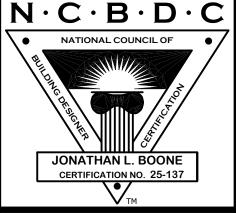
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